Core House Type Working Drawings -

: Elevations	Rev C
: Ground Floor Plan	Rev C
: First Floor Plan	Rev B
: Services S/O Plan B&B	Rev C
: FF Joist Layout	Rev A
: Roof Layout	Rev B
: Section A-A	Rev B
: Kitchen Plan - Gold	Rev -
: WC Layout AD M CAT 1	Rev -

HTV CODE: SH86-E-7 DR00

For Electric vehicle charging location refer to drawing H7787-007

THIS DRAWING IS COMPLIANT WITH 2013 & 2015 BUILDING REGULATIONS

Detailed Revision Description

Rev Description

Do Bespoke drawing for Dunmore Road, based on the group type SH76-E-7 DS00. Plot no's added.


House lengthened by 40mm to comply with S106 requirements. Deepflow gutters noted. Window sash horns removed from elevations. Buttress wall added

O1 Ground floor construction updated. External door height updated on schedule. Bath partition updated. Escape windows updated. Front door amended to 944mm structural

CONSTRUCTION ISSUE

SH76-EG7 PLOT NUMBERS:

AS: 199 OPP: 194

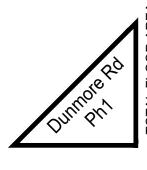

TOTAL FLOOR AREA: 1041sqft / 96.76msq Sales Name: .

Drawing No: -Checked: SH

Spec: SOCIAL

Drawn: SH

House Type Code: SH76-EG7

04.02.21 DATA SHEET

O1 Refer to Data Sheet for full details Date: Oct 2018

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Windows:

All upper floor windows to be provided with lockable window handles on non secure be design sites

Part Q:

For windows at ground floor and accessible windows above canopies ETC

- * Toughened & clear ** Toughened & obscure
- Q = Part Q compliance windows

Extract fan locations drawn to comply with zero-plotting, where HTs are not zero-plotted extracts should be taken through wall or shortest route

5mm continuous ridge ventilation


150mm fascia 250mm soffit


Cavity tray & code 4 lead flashing to all abutment

Stormking or similar approved GRP canopy (min 900mm width x 600mm depth)

Window handle to W1 to be positioned between 450 and 1200mm above ffl. All other windows handles to be positioned between 450 and 1400mm above ffl.

- 1 course contrasting brick stretcher band projecting 15mm, beneath W1 cill to front elevation with 440mm returns to gable
- 1 course contrasting brick stretcher feature band projecting 15mm, above and beneath rear windows

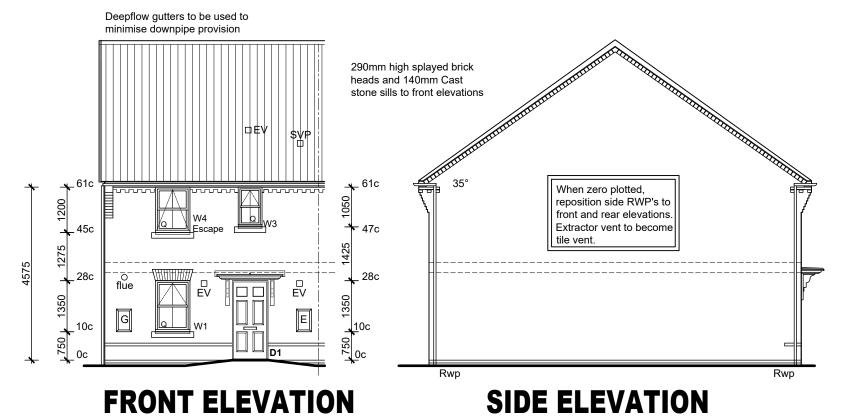

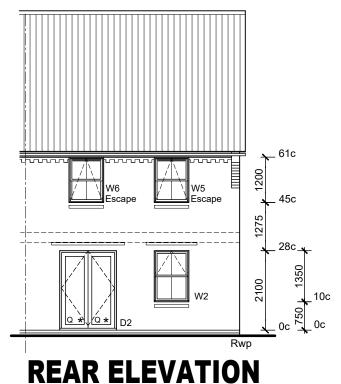

TOTAL FLOOR AREA: 1041sqft / 96.76msq

House Type Code: SH76-EG7 Sales Name:

Date: Oct. 2018

Drawing No: 01 Checked: SH

Spec: SOCIAL


Drawn: SH

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Refer to Data Sheet full details

ELEVATIONS

THIS DRAWING IS COMPLIANT WITH 2013 & 2015 BUILDING REGULATIONS

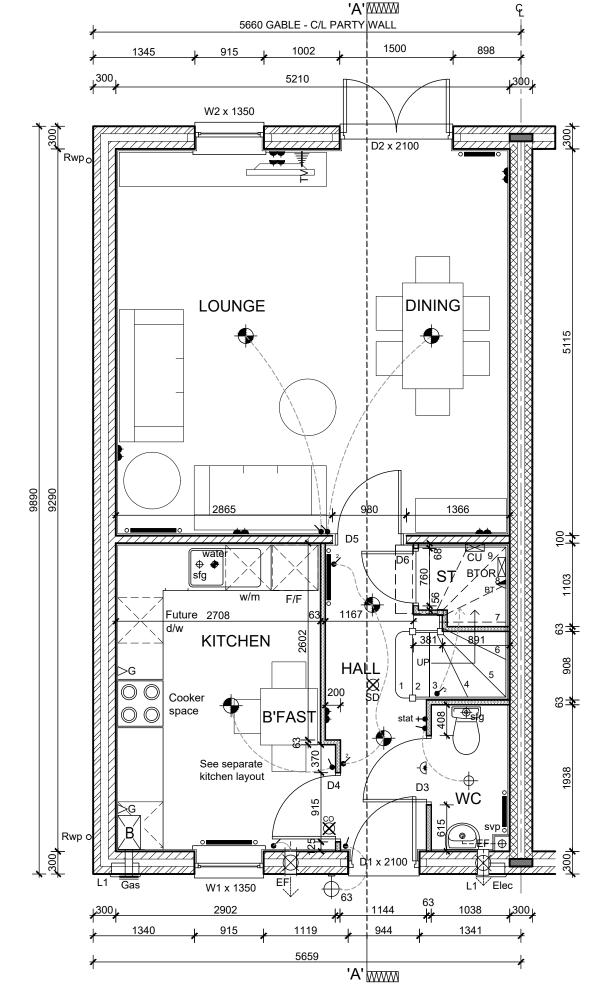

Extract vent from cooker hood.

SVP with 2 layers of 12.5mm plasterboard packed with quilt.

RWP positions may differ from that shown. For actual location refer to site

Level threshold to Part M 2004 as Standard Detail.

Level approach to front entrance max gradient 1:20 min 900mm with (Part M 2004)

15mm Gyproc plasterboard to underside of stairs for fire protection

Boiler flue outlet to be min 300mm from door/window opening

Electric and Gas meter box to be wall

Sockets, switches, stopcocks and controls to be positioned a min 300mm horizontally from an inside corner.

WALL KEY

Facing Brickwork (Ext Walls - Ext Leaf)



Aircrete Blockwork Refer to Specification for block strength (Ext Walls)



Medium Density or Aircrete Blockwork (Party Walls) Refer to Specification to block strength

Acoustic insulation to timber stud partitions

Lightswitch - 2 way

BTOR 🛛

Extract Fan isolator switch with 'FAN' label/symbol @ H.L. centred above door

Specification if to be utilised on site.

Consumer unit - fixed 1350mm -

1450mm from FFL

Thermostat

Lightswitch

ELECTRICAL SYMBOLS KEY

SD 💢

Ceiling mounted extract fan

Carbon Monoxide Detector.

or window min 150mm from ceiling.

Pendant light fitting with Low Energy bulb

Batten light fitting with Low Energy bulb

IPX4 batten light fitting with Low Energy bulb

Wall mounted light fitting with Low Energy bulb

BT Open Reach Location - Refer to Trade

To wall - located above the height of any door

To Ceiling - located min 300mm from any wall.

Wall mounted extract fan

Smoke Detector

Heat Detector

Shaver socket outlet

Immersion switch

Fluorescent Strip light fitting

Gas point Double socket outlet

MP Media Plate

DOOR SCHEDULE				
Door Ref	Door Size (widthxheight)	Door weight(kg)	Lintol Ref (kg)	Fire Door
D1	838 x 2013mm	60	L1/S 100 1350 (8.93)	No
D2	1500 x 2100	N/A	L1/S 100 1800 (14.02)	No
D3	838 x 1981mm	16.2	N/A	No
D4	838 x 1981mm	16.2	N/A	No
D5	838 x 1981mm	16.2	N/A	No
D6	610 x 1981mm	10.5	N/A	No

WINDOW SCHEDULE			
Window Ref	Struct opening (widthxheight)	Lintol Ref (kg)	Fire Escape
W1	915 x 1350mm	L1/S 100 1200 (7.15)	No
W2	915 x 1350mm	L1/S 100 1200 (7.15)	No

ОТ	HER OPENINGS
11	Motor Box Support Motor Box Lintols 0750 (2.21) v2

TOTAL FLOOR AREA: 1041sqft / 96.76msq

Date: Oct 2018 Drawing No: 03 Checked: SH House Type Code: SH76-EG7 Spec: SOCIAL Sales Name: Drawn: SH

Scale: 1:50

HOMES

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04.02.21

GROUND FLOOR PLAN

A Refer to Data Sheet for full details

THIS DRAWING IS COMPLIANT WITH 2013 & 2015 BUILDING REGULATIONS

ELECTRICAL SYMBOLS KEY

EF 💢 Ceiling mounted extract fan

EF 💢 Wall mounted extract fan

SD 💥 Smoke Detector

co 💢 Carbon Monoxide Detector.

To wall - located above the height of any doc or window min 150mm from ceiling. To Ceiling - located min 300mm from any wa

Heat Detector

Shaver socket outlet

Immersion switch

Gas point

HD 💥

Double socket outlet

Fluorescent Strip light fitting

Pendant light fitting with Low Energy bulb

Batten light fitting with Low Energy bulb

IPX4 batten light fitting with Low Energy bulb

Wall mounted light fitting with Low Energy bu

TV ---|| TV point

вт 🚄 Telephone point

CU Consumer unit - fixed 1350mm -1450mm from FFL

BT Open Reach Location - Refer to Trade BTOR 🛚 Specification if to be utilised on site.

Lightswitch - 2 way

Extract Fan isolator switch with 'FAN' label/symbol @ H.L. centred above door


Thermostat

MP Media Plate

DOOR SCHEDULE				
Door Ref	Door Size (widthxheight)	Door weight(kg)	Lintol Ref (kg)	Fire Door
D7	686 x 1981mm	12.5	N/A	No
D8	762 x 1981mm	17.0	N/A	No
D9	686 x 1981mm	12.5	N/A	No
D10	762 x 1981mm	17.0	N/A	No
D11	762 x 1981mm	17.0	N/A	No

WINDOW SCHEDULE			
Window Ref	Struct opening (widthxheight)	Lintol Ref (kg)	Fire Escape
W3	630 x 1050mm	L1/E 100 0900 (6.30)	No
W4	915 x 1200mm	L1/E 100 1200 (8.40)	Yes
W5	915 x 1200mm	L1/E 100 1200 (8.40)	Yes
W6	915 x 1200mm	L1/E 100 1200 (8.40)	Yes

THIS DRAWING IS COMPLIANT WITH 2013 & 2015 BUILDING REGULATIONS

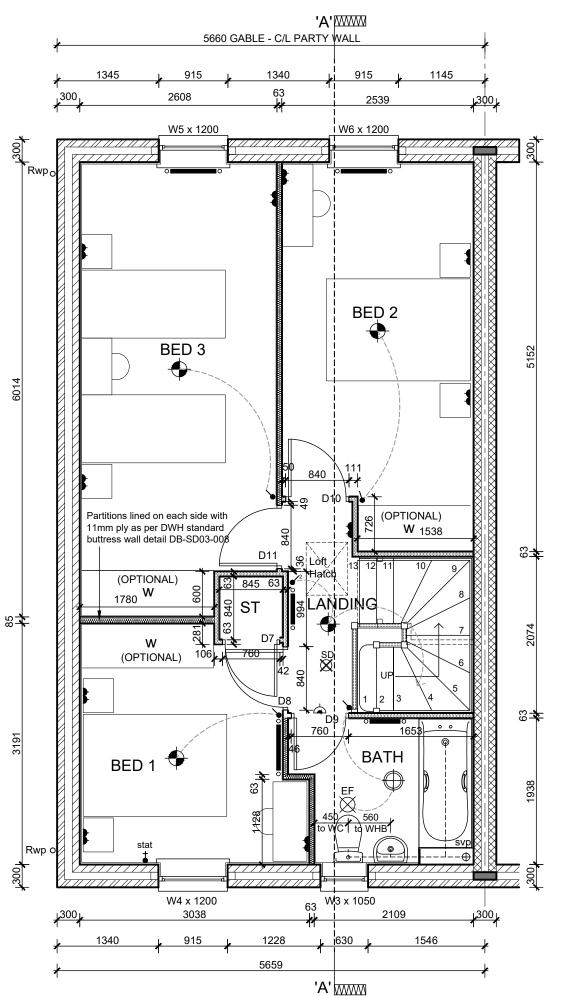

Stair balustrade and handrail min 900mm

SVP with 2 layers of 12.5mm plasterboard packed with quilt.

RWP positions may differ from that shown. For actual location refer to site specific drainage layout.

WALL KEY

Facing Brickwork (Ext Walls - Ext Leaf)

Aircrete Blockwork Refer to Specification for block strength (Ext Walls)

Medium Density or Aircrete Blockwork (Party Walls) Refer to Specification to block strength

Acoustic insulation to timber stud partitions

SH76-EG7 House Type Code: Sales Name:

TOTAL FLOOR AREA: 1041sqft / 96.76msq

Date: Oct 2018 Drawing No: 04 Spec: SOCIAL

Scale: 1:50

Checked: SH

Drawn: SH

HOMES


DAVID WILSON

4

Refer to Data Sheet for full details **FLOOR PLAN**

FIRST

<u>|</u> _

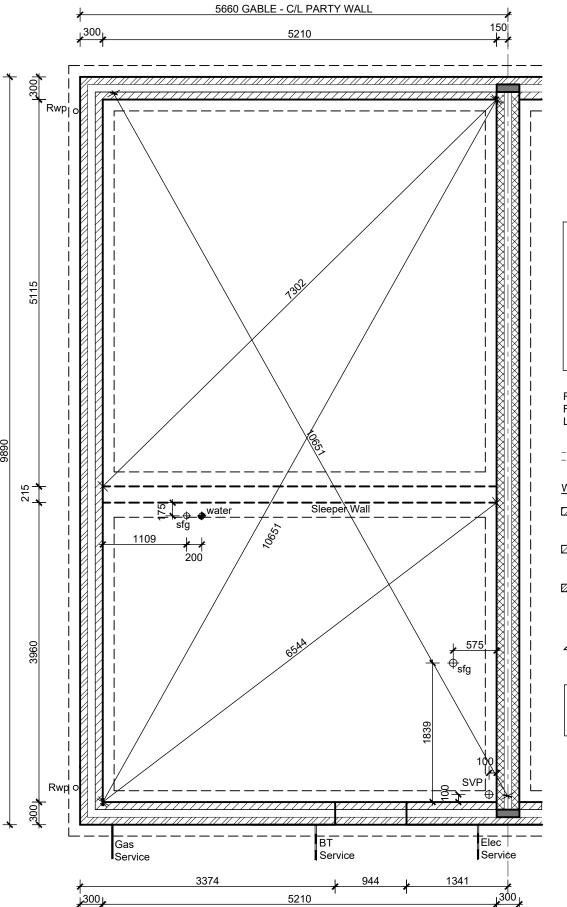

FOUNDATIONS

Foundation widths / type are indicative only. Refer to Structural Engineers' Foundation and B & B Design for detailed information.

For plot specific Foundation Design refer to Site Structural Engineers' information.

Depth of foundation to satisfy NHBC requirements and to be agreed on site with approved inspector.

Rwp positions may differ from those shown. For actual location refer to Site Drainage Layout.

Sleeper blockwork walls below.

WALL KEY:

Facing Brickwork (Ext Walls - Ext Leaf)

Aircrete Blockwork - refer to specification for block strength (Ext Walls - Int leaf & Int Walls)

Medium density or Aircrete
Blockwork (Party Walls) refer to
specification for block strength

Denotes direction for NuSpan floor to span.

THIS FOUNDATION LAYOUT IS ONLY TO BE USED IN CONJUNCTION WITH THE APPROVED NUSPAN DESIGN.

TOTAL FLOOR AREA: 1041sqft / 96.76msq

Sales Name: .

House Type Code: SH76-EG7

Spec: SOCIAL Drawing No: 05 Date: Oct 2018


Drawn: SH Checked: SH Scale: 1:50

DAVID WILSON HOMES

SERVICES S.O. PLAN B&B

B Refer to Data Sheet for full details

THIS DRAWING IS COMPLIANT WITH 2013 & 2015 BUILDING REGULATIONS

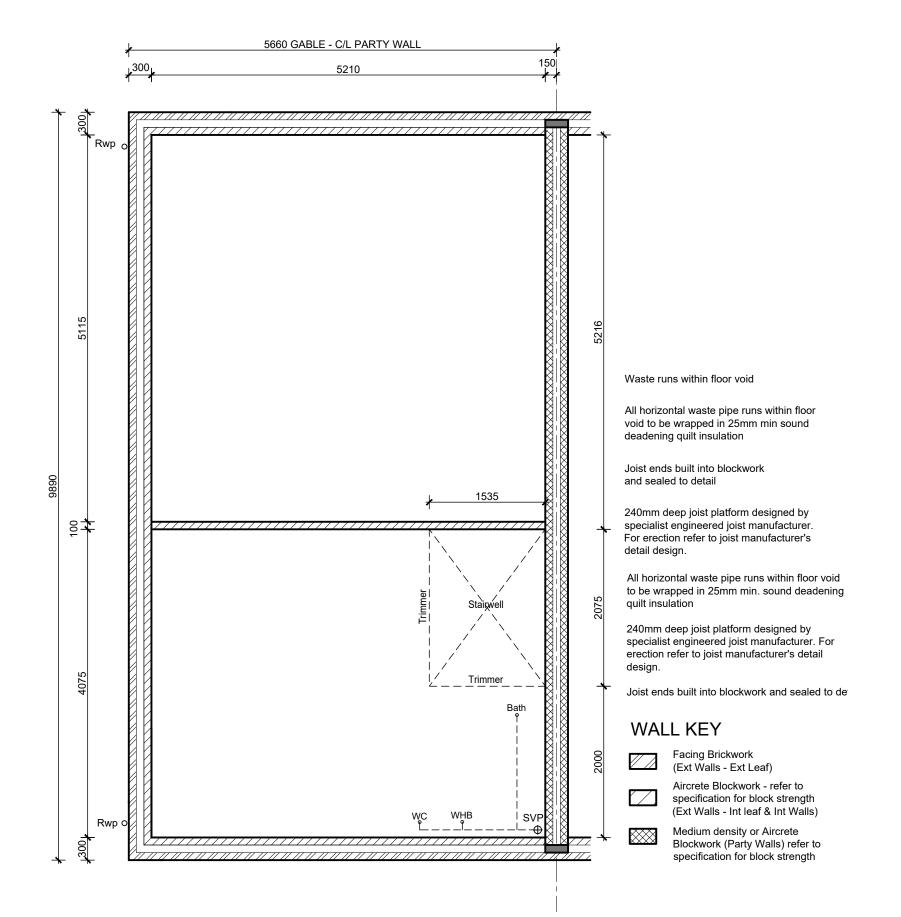

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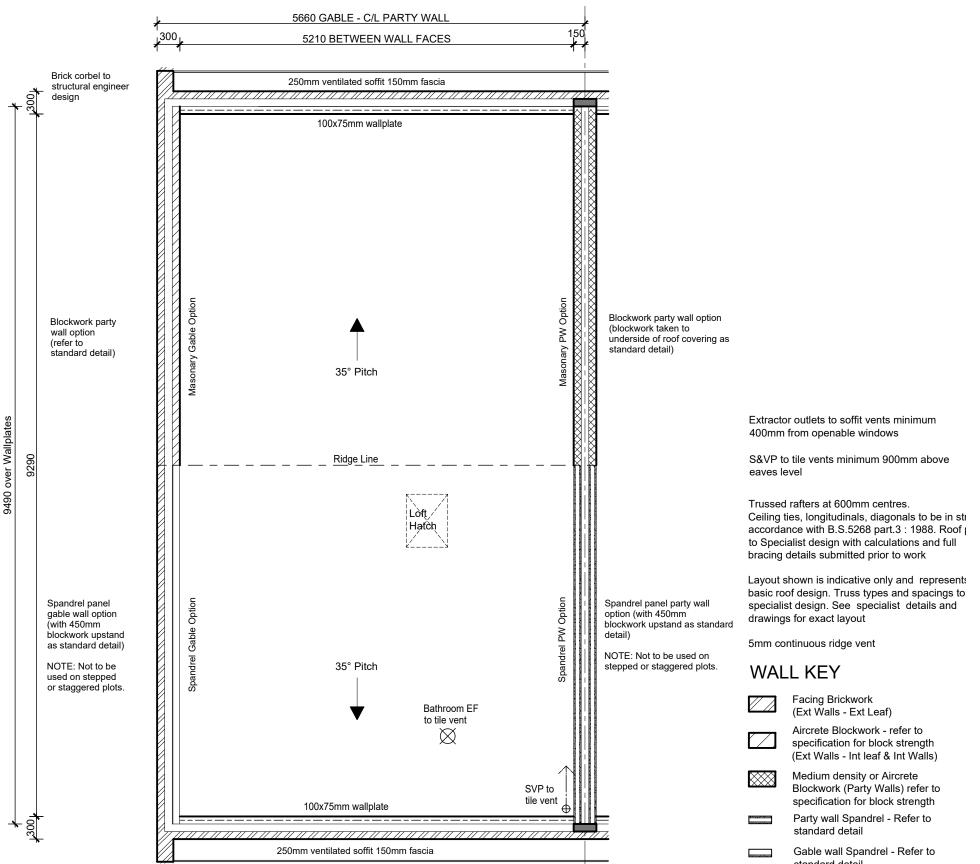
Date: Oct 2018 Drawing No: 06 Checked: SH House Type Code: SH76-EG7 Spec: SOCIAL Sales Name: Drawn: SH

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13.07.20

FIRST FLOOR JOIST LAYOUT

A Refer to Data Sheet for 13.07 full details



TOTAL FLOOR AREA: 1041sqft / 96.76msq

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Refer to Data Sheet for full details

Date: Oct 2018

Drawing No: 07

Spec: SOCIAL

Drawn: SH

House Type Code: SH76-EG7


Sales Name:

Checked: SH

ROOF PLAN

B Refer to Da

standard detail

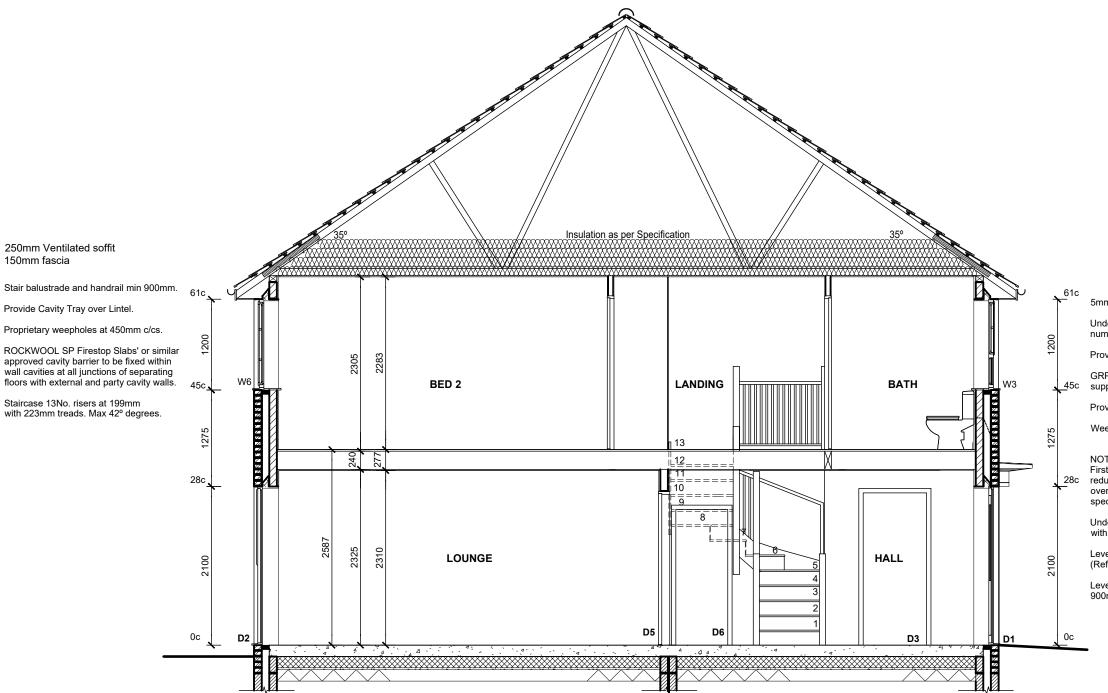

5mm continuous dry ridge ventilation.

Underside of roof structure to be lined with one number layer of 15mm Gyproc wallboard.

Provide Cavity Tray over Canopy flashing.

GRP canopy by approved Group supplier to feature brick surround

Provide Cavity tray over lintel.

Weepholes at 450mm c/cs.

NOTE:

First floor construction provides 40db sound reduction and comprises of 22mm chipboard over 240mm deep proprietary timber joists to specialist design.

Underside of timber floor structure to be lined with one number layer of 15mm Gyproc wallboard.

Level threshold to Part M 2004 (Refer to Standard Detail).

Level approach to front entrance max gradient 1:20, 900mm width (Part M 2004).

For plot specific foundation design, refer to structural engineers information.

Depth of foundation to satisfy NHBC requirements and to be agreed on site with BCO.

Date: Oct 2018 Scale: 1:50 Drawing No: 08 Checked: SH House Type Code: SH76-EG7 Spec: SOCIAL Sales Name: Drawn: SH


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Refer to Data Sheet for full details

SECTION A-A

B Refer to Data

150mm fascia

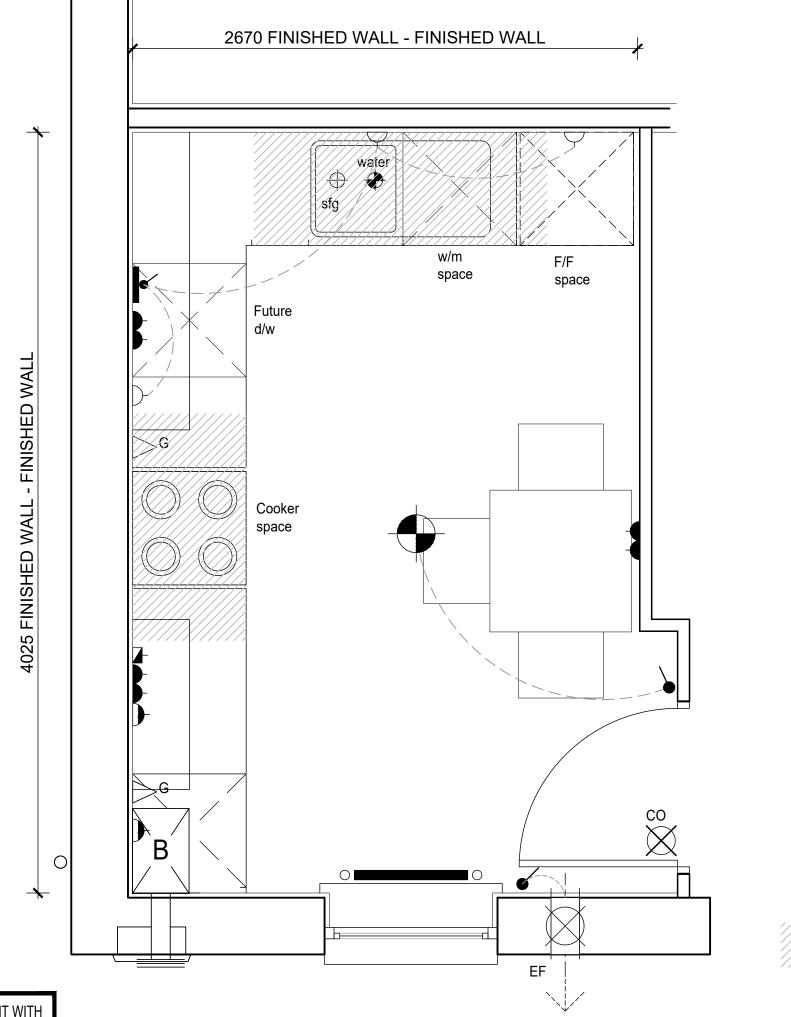

KITCHEN SYMBOLS KEY

Oven and hob panel

Double socket outlet

Low level socket

Cooker hood or Boiler point

Lightswitch

Lightswitch - 2 way

Multi switch panel (to all appliances)

Switch with low level socket

Fluorescent Strip light fitting

Batten light fitting with low energy bulb

Pendant light fitting with low energy bulb

Downlighter recessed into ceiling

LED lighting fitted below wall units

CU

 $\overset{\circ}{\boxtimes}$

Telephone Point

Consumer Unit - fixed 1350mm - 1450mm from FFL

Ceiling mounted extract fan

Ceiling mounted extract fan

Carbon monoxide detector To wall - located above the height of any door or window min 150mm from ceiling. To ceiling - located 300mm

Heat detector

Sealed floor gulley

Soil vent pipe

Denotes shaded 300mm zone. No electric sockets etc above worktop to be placed within this zone. TOTAL FLOOR AREA: 1041sqft / 96.76msq

House Type Code: SH76-EG7 Sales Name:

Drawing No: 09 Checked: SH Spec: SOCIAL


Drawn: SH

Date: Oct 2018 Scale: 1:25

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KITCHEN LAYOUT - GOLD
Rev: Refer to Data Sheet for full details

THIS DRAWING IS COMPLIANT WITH 2013 & 2015 BUILDING REGULATIONS

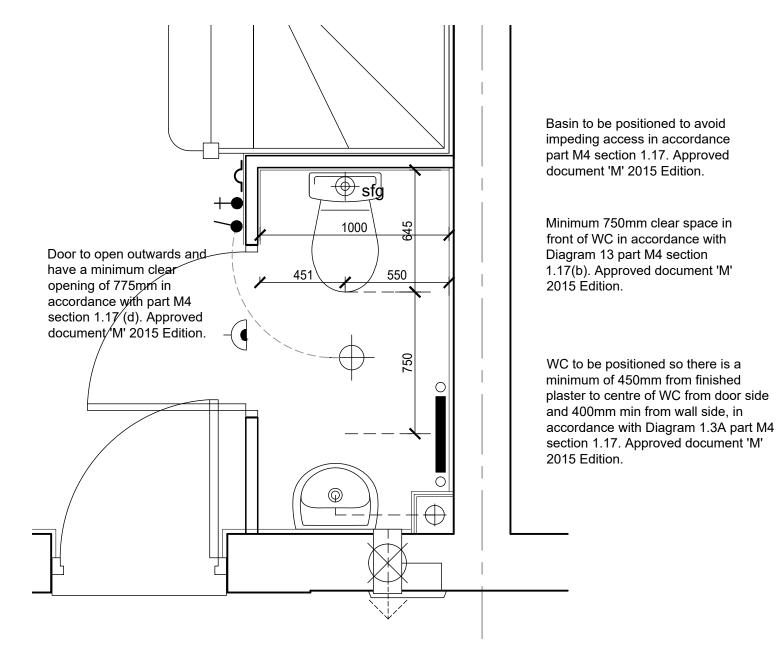

DAVID WILSON HOMES

Date:

WC LAYOUT CAT 1

Rev: Refer to Data Sheet for full details

Date: Oct 2018 Drawing No: 10 Checked: SH House Type Code: SH76-EG7 Spec: SOCIAL Sales Name:

Drawn: SH

TOTAL FLOOR AREA: 1041sqft / 96.76msq